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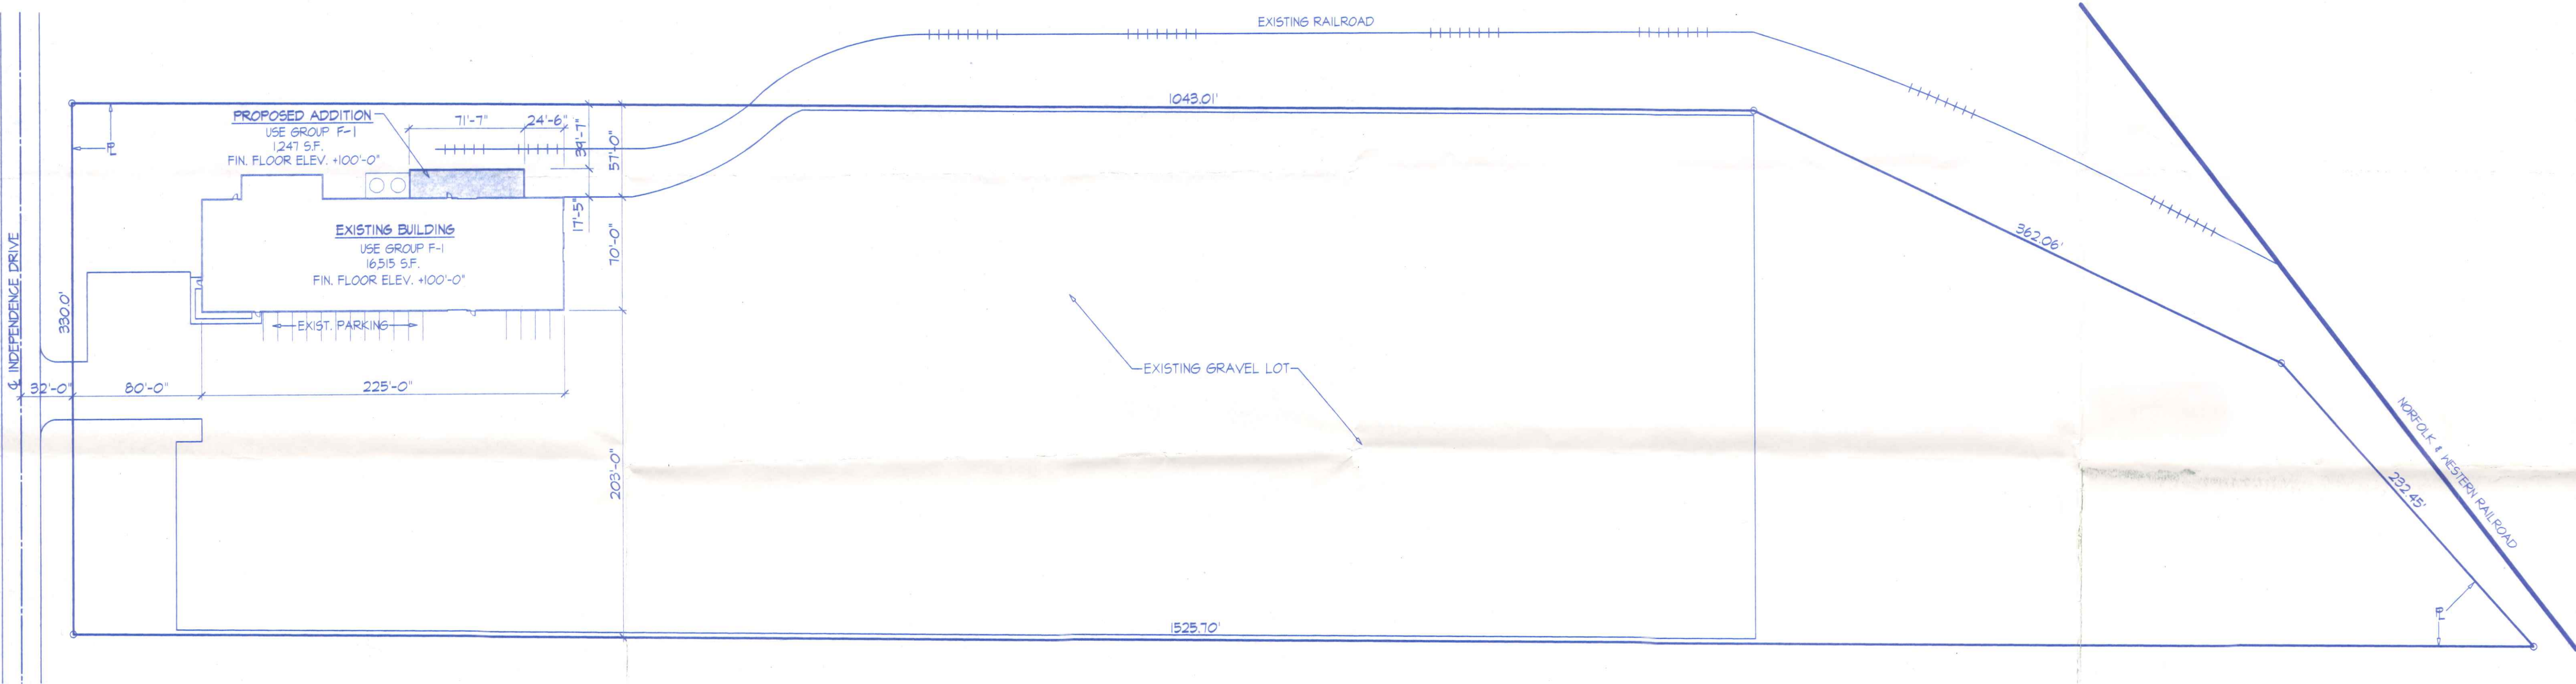
BUILDING CODE DATA	
USE GROUP	- F-1 (FACTORY)
FIRE GRADING	- 3 HOUR (F-1)
CONSTRUCTION TYPE	- 2C
OCCUPANCY LOAD	- 12 (NEW ADDITION)
DESIGN LIVE LOADS	
FLOOR SLAB	- 300 PSF.
ROOF	- 25 PSF.
WIND	- 80 MPH. (EXPOSURE C)
GROUND SNOW LOAD	- 25 PSF.
ROOF SNOW LOAD	- 17.5 PSF. Ce = 0.7 I = 1.0
SEISMIC DESIGN DATA:	
Av = 0.08	Aa = 0.10
SHEG - Group 1	SPC - B
S = 2.0	R = 5
Cd = 4 1/2	Analysis Procedure - Section 1612.4 OBBG.

This facility has a backflow device on the fire line already. The addition will be sprinkled.

REVISIONS	BY
PERMITS 07-13-99	D.S.

SCOPE OF PROJECT:

THIS MANUFACTURING FACILITY IS USED TO PRODUCE PLASTIC DRAINAGE TILE. THE EXISTING OFFICE AREA IS USED FOR BUSINESS PURPOSES RELATED TO THE SALE OF THIS PRODUCT.



SITE PLAN
SCALE 1" = 50'-0"

NOTE:
AN APPROVED AUTOMATIC FIRE SUPPRESSION SYSTEM SHALL BE INSTALLED THROUGHOUT THE ENTIRE ADDITION IN ACCORDANCE WITH NFPA-13 AND THE O.B.B.C., LATEST EDITION.

1075 Independence

SITE PLAN
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PROPOSED ADDITION TO
ADVANCE DRAINAGE SYSTEMS, INC.
1075 INDEPENDENCE DRIVE NAPOLEON, OHIO

Date	07-13-99
Scale	AS NOTED
Drawn	J.M.H.
Job	99010
Sheet No.	

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